City Collective

Uniting on Hawker

2-10, 12, 14, 16, 18 Market Place & 105 Gibson Street, Bowden

Architectural Planning Report







City Collective

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Client

UnitingSA

Date

20 March 2025

Description

2-10, 12, 14, 16, 18 Market Place & 105 Gibson Street, Bowden Architectural Planning Report

Produced for

UNITING SA Housing

City Collective acknowledge the Traditional Owners of Kaurna land, the land where we work and live. We pay our respects to Elders past, present and emerging. We celebrate the stories, culture and traditions of Aboriginal and Torres Strait Islander Elders of all communities who also work and live on this land.

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O1 Introduction & Site Context




Executive Summary Vision & Principles

The 'Uniting on Hawker' Bowden housing project has the potential to be an innovative, diverse and inclusive housing development that prioritises the local community through empathic & contextually responsive design.

- UnitingSA has identified an opportunity for a 30-dwelling social and affordable housing development for an amalgamated site in Bowden
- 'Uniting on Hawker,' targets a yield of 30 apartments across two levels
- The **target cohort** for the social housing is women aged 55 and over who are experiencing or at risk of homelessness





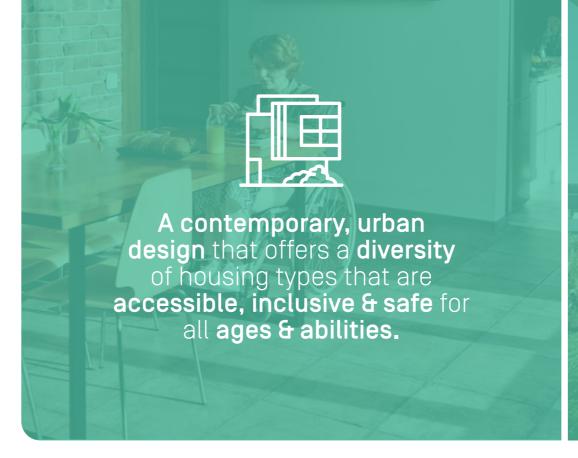



A contemporary, urban design that is a champion for holistic sustainability that reduces operating costs & improves user comfort.

Our Undestanding of the Site

- Amalgamated site area of 2,950sqm
- Interface with Market Place and Hawker Street
- Directly adjacent Gawler Railway Line


Legend

- 2 storey dwellings in the local context
- 3 Storey dwellings in the local context



What to Build On Opportunities

- Maximise Hawker Street Frontage
 Replace solid brick fences with active residential frontages engaged with the street
- Maximise Solar Access
 Site geometry creates opportunities for good solar access through the day
- Capitalise on Rail Interface
 Existing road reserve creates separation from rail corridor, and an opportunity to focus density and height, mirroring the condition to the East

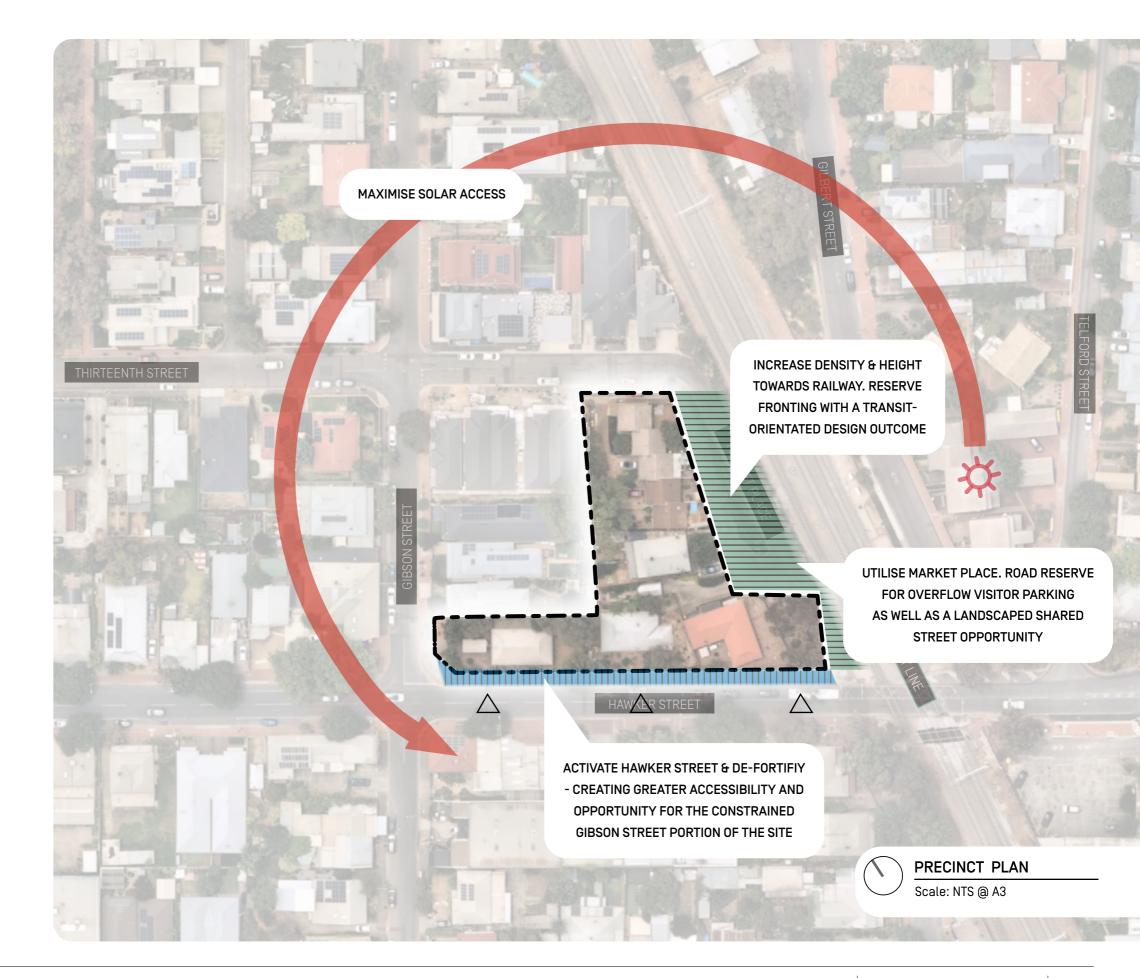

What Additional Parameters Exist?

Site Configuration


- Narrow pinch points
- Regulated Tree

Planning Policy

- Height limitations of planning overlay
- Height sensitivities to Thirteenth Street interface
- Area Minimum for Dwellings
- Rear Setbacks
- Representative Heritage Place

Interfaces & Rail Corridor

• Hawker Street Crossover

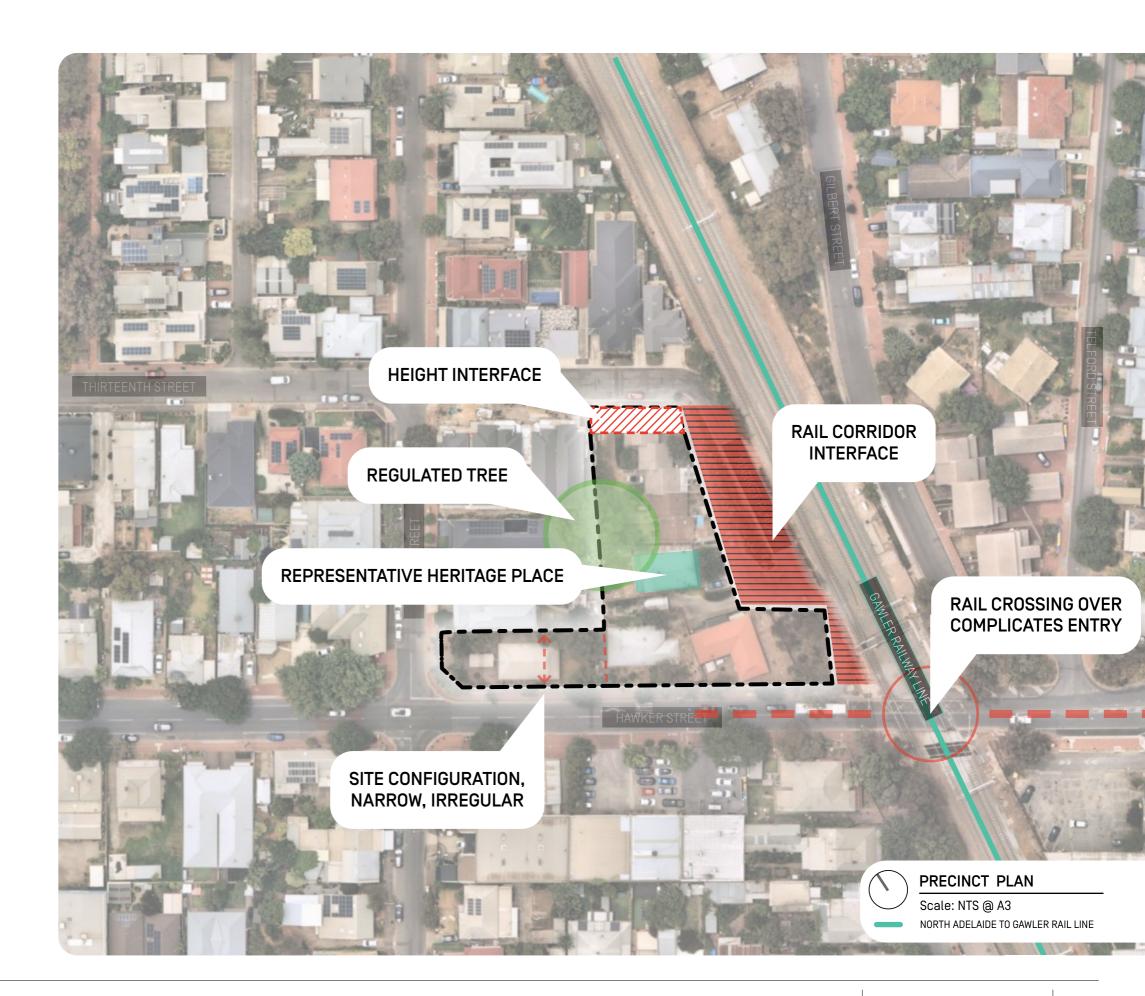



Our Vision for the Site

History & Context

- This area has a history of offering affordable housing for the local community, from traditional workers cottages from the early 1900"s, to housing trust townhouses from the 1970's - This community has a history of reflecting the need for providing affordable housing
- This reflects how the character of an area emerges, and how cities evolve and grow, by developing housing that meets the needs of the community at a moment in time.

Our Vision

- It is our goal to develop a design framework that reflects and responds to the current moment of time, to define a new design approach that meets today's housing needs, especially to those at risk-members of the community needing affordable accommodation
- This framework should reference and be contextually appropriate to the area, while employing **contemporary design solutions** classic residential forms, in a contemporary expression

Key Interfaces

- We have 4 distinct interfaces, that take slightly different approaches to responding to the planning and heritage parameters:
 - The Northern Market Place interface adjacent newly constructed 2 storey townhouses and older single storey housing stock
 - The Eastern Railway interface opposite a 3 storey development in the immediate area
 - The Southern Hawker Street interface the visual gateway to Hawker Street
 - The Hawker Street Apartments Adjacent 2 storey dwellings





















Addressing Historic Area Overlay Provisions

PO 1.1: All development is undertaken having consideration to the historic streetscapes and built form as expressed in the Historic Area Statement.

- Development has taken the formal and material characteristics expressed by the HAS statement, and incorporated them in a contemporary fashion, appropriate to the building typology.
- Materiality has been directly informed by the HAS statement, with colour choices making reference to specific examples in the area, reinterpreted through a more contemporary lens

PO 2.1: The form and scale of new buildings and structures that are visible from the public realm are consistent with the prevailing historic characteristics of the historic area.

- Lower level has been reinforced visually, with prominent articulation, use of heavier masonry materials, and datum lines specifically expressing height references in the locality
- Upper level has been set back and reduced in appearance to Market Place to the North through use of recessive elements and a change to lightweight metal cladding, and with increased setback to Hawker Street for additional visual relief to the street

PO 2.2: Development is consistent with the prevailing building and wall heights in the historic area.

- Heights and setbacks are in alignment with adjacent two storey residential developments to the West and North.
- Hawker Street streetscape has similar setbacks to current brick fence, but with greater level of vertical setbacks, increased void to solid ratio, and increased capacity for landscaping at street edge.

PO 2.3: Design and architectural detailing of streetfacing buildings (including but not limited to roof pitch and form, openings, chimneys and verandahs) complement the prevailing characteristics in the historic area

- The Two Storey apartment component on Hawker St, incorporates a contemporary interpretation of traditional gable end forms
- Balconies are expressed, and proportionally respond to traditional verandah forms
- Parapet roof forms are recessed back from the street to create visual relief, and mansard style forms used on upper levels on Market Place to introduce the appearance of sloped roof forms

PO 2.4: Development is consistent with the prevailing front and side boundary setback pattern in the historic area.

- Heights and setbacks are in alignment with adjacent two storey residential developments to the West and North
- Proportionality of vertical masses reduce the appearance of long flat elevations, especially the stepped facade of the Railway interface, which has specific reference to the existing housing trust buildings on site.


PO 6.1: The width of driveways and other vehicle access ways are consistent with the prevailing width of existing driveways of the historic area.

 Driveways and crossovers on site have been reduced to a minimum, and are generally kept to side boundaries of building forms

PO 6.2: Development maintains the valued landscape patterns and characteristics that contribute to the historic area, except where they compromise safety, create nuisance, or impact adversely on buildings or infrastructure.


 Generally, landscaped areas have been provided at street edge conditions in front of balustrades to private open space, to soften street edge, and provide additional opportunities for natural screening and privacy

Establishing Four Key Frameworks

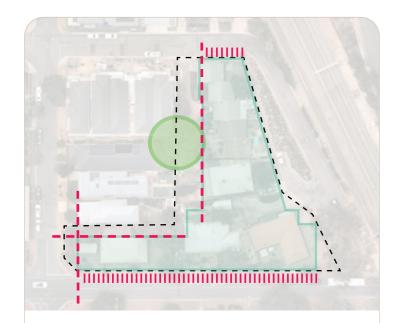


Step 1: Setbacks and Interfaces

Establish setbacks and key interfaces with respect to adjacent properties, Heritage Area Statement, and preservation of Significant Tree

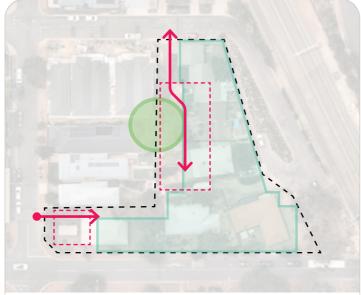


Step 2 : Carparking and Security

Consolidate and tuck parking to rear boundaries of site to create a secure parking compound that minimises crossovers, and reduces appearance of parking from street.

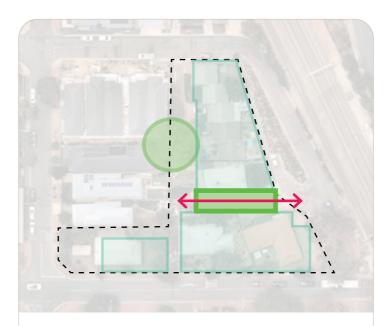

Step 3 : Divide Building Mass

Create separation between wings of built form to reduce appearance of scale contiguous building mass, and create opportunities for secure internalised community space.

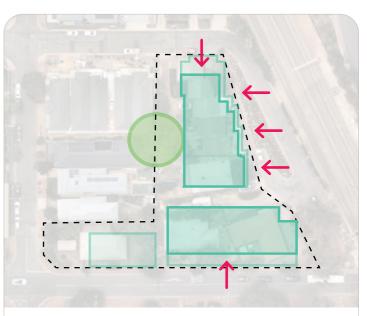

Step 4: Refine Building Mass

Sculpt building mass further to create setbacks, articulation, and geometries that serve to reduce the appearance of building scale, and increase visual setback of upper levels from the street.

Design Response: Materiality

Responding to History and Context

- Our material palettes have been developed in line with the heritage advice provided, and kept to simple and robust choices.
- Generally, brickwork and lighter coloured textural panels have been used to articulate lower levels, and the darker coloured corrugated sheet has been used to denote the recessive upper level elements
- **Timber has been used in select areas** to provide a textural break along façades, especially at junctions between building masses

Hawker Street Southern 2 Storey Interface





This palette takes cues from typical colour schemes found in the trust housing currently on site, and throughout the locality, as a reference to the history of the site, as well as the colour qualities of the stonework found on local character examples.







Hawker Street Northern 2 Storey and Railway Interface







This palette is more specifically inspired by the appearance of the representative building, and several other character homes in the area, which have a contrast of green metalwork, to light coloured finishes. The pale green and white brick is a more contemporary interpretation







Streetscape Context



Street Elevation - Hawker Street

Scale: 1:500 @ A3



Street Elevation - Market Place / Thirteenth Street

Scale: 1:500 @ A3

/Architecture

: 1:500 : CONCEPT DESIGN

Massing and Interfaces

General Response

- 1. Ground Floor setbacks with landscaping to provide softening and relief at street edge
- 2. Articulation at corners to address key gateway views along Hawker Street
- 3. Reinforcement of vertical recessed elements to create appearance of single dwelling proportionality and rhythm along streetscape

Hawker Street Apartments South (2 Storey)

- 4. Heights aligning to typical adjacent two storey developments
- 5. Progressive increasing setbacks to balustrades and parapet forms to increase visual relief from street edge

Hawker Street Apartments North (2 Storey)

- 6. Heights and setbacks in alignment with adjacent two storey residential developments
- 7. Gable end roof forms as contemporary application of traditional roof form



Massing and Interfaces

General Response

- 1. Heights aligning to typical adjacent two storey developments
- 2. Additional setbacks and mansard-style forms to upper level in darker contrasting colours to further reduce appearance of upper level, and reduce the appearance of parapet forms to give more unique identity to this part of the site
- 3. Large separation between wings of building to create appearance of multiple unique smaller building forms on site
- 4. Expressed balconies to provide greater articulation to façades, in reference to historic verandah forms typical to the character of the area

Market Place North

- 5. Height and facade articulation of primary mass in alignment with adjacent new two storey residential developments
- 6. Increased setback of upper level to provide greater visual relief at street edge


Railway interface East


7. Stepped footprint and vertical separation to create rhythm and break-up facade



O3 Architectural Drawings



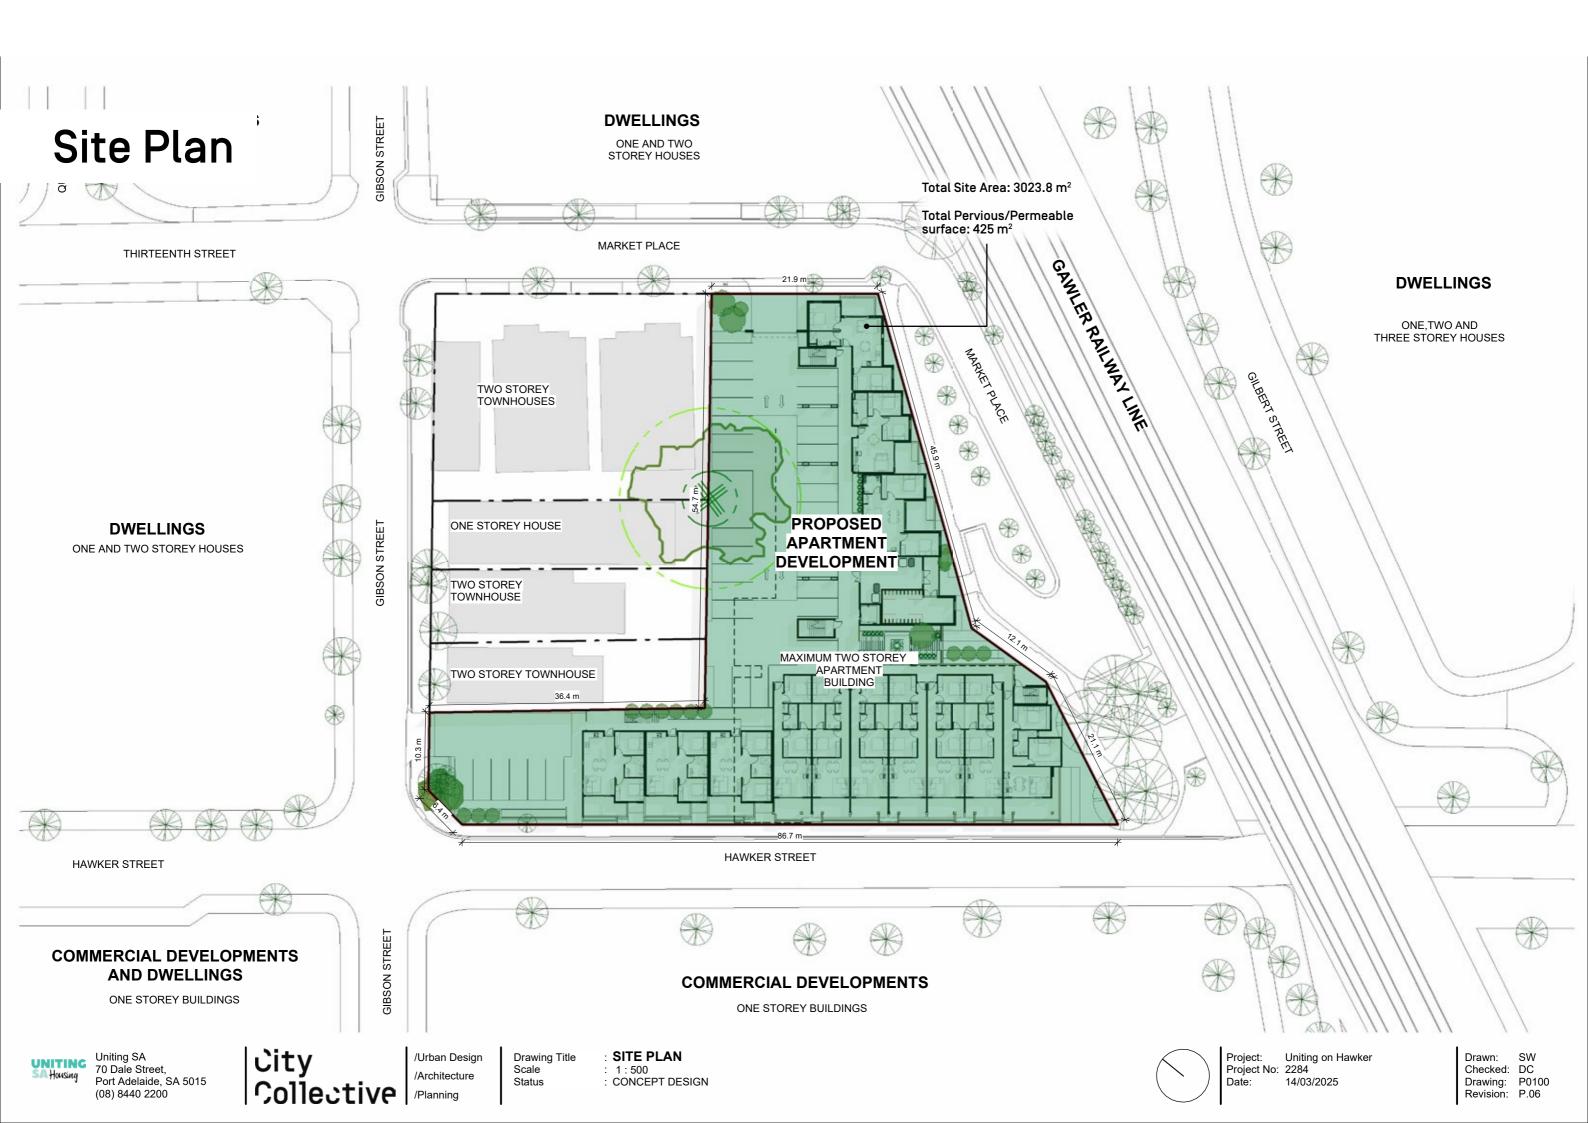

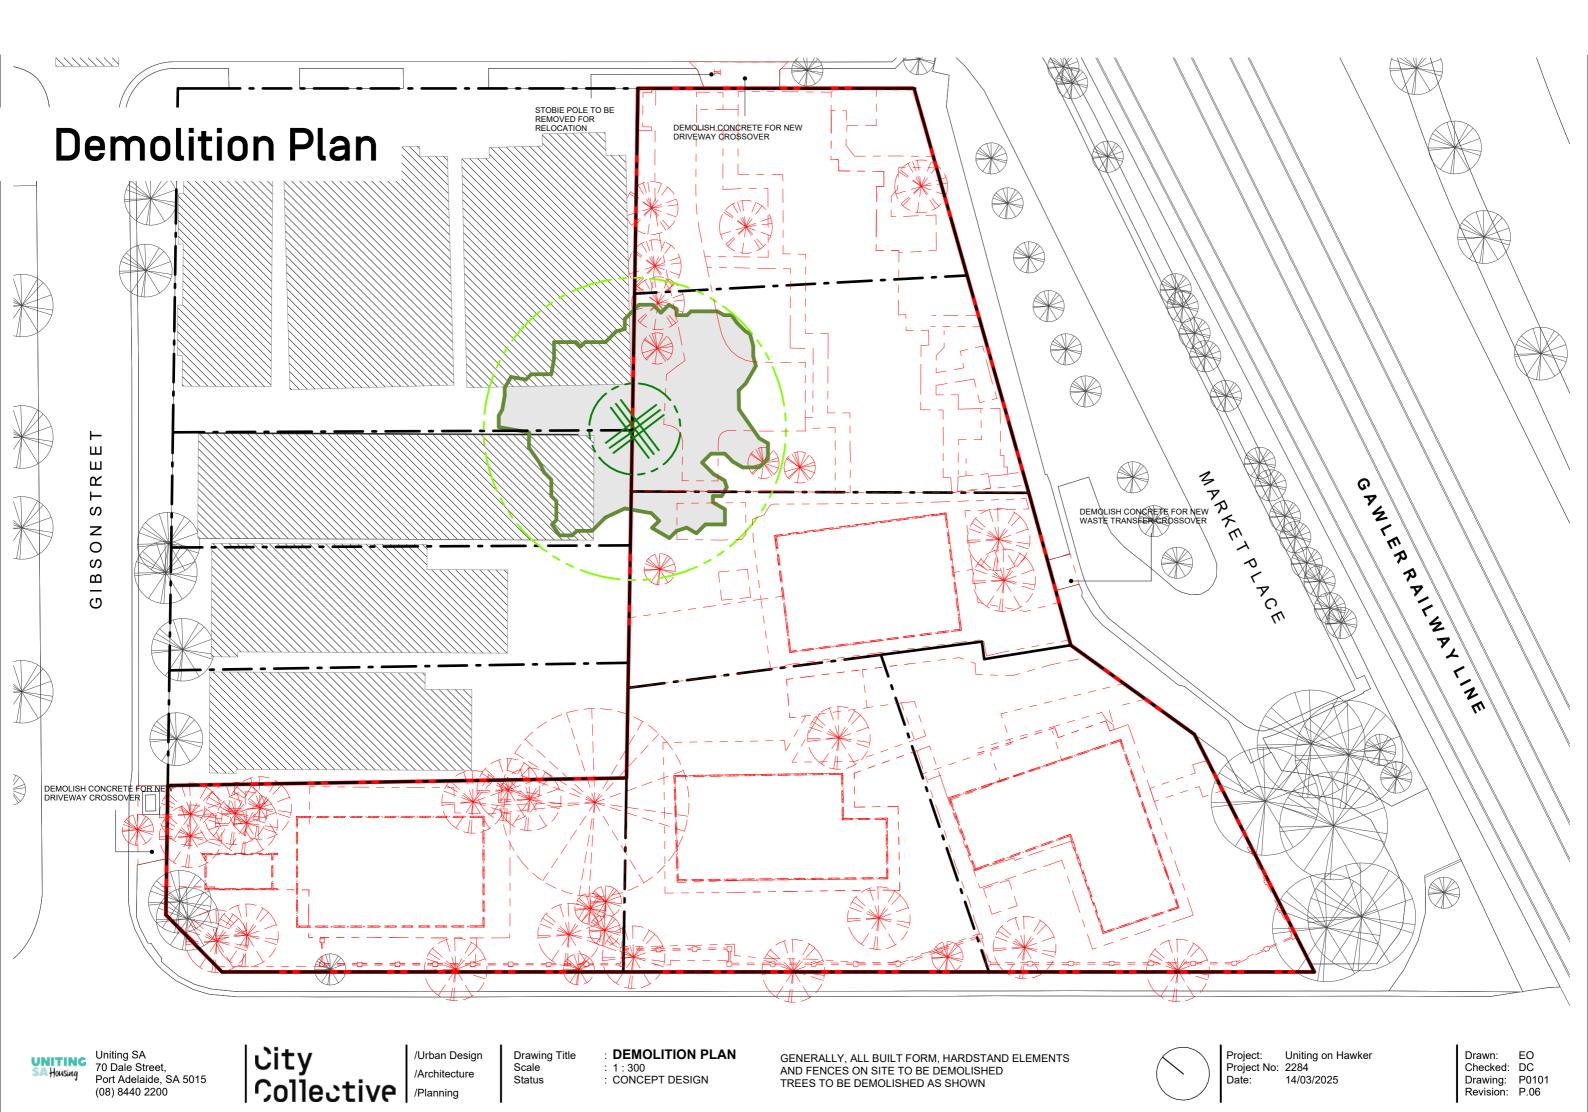







/Urban Design Status


Drawing Title Scale

GROUND FLOOR PLAN : 1:300 : CONCEPT DESIGN



Uniting on Hawker Project: Project No: 2284

Drawn: Checked: DC Drawing: P1000 Revision: P.06

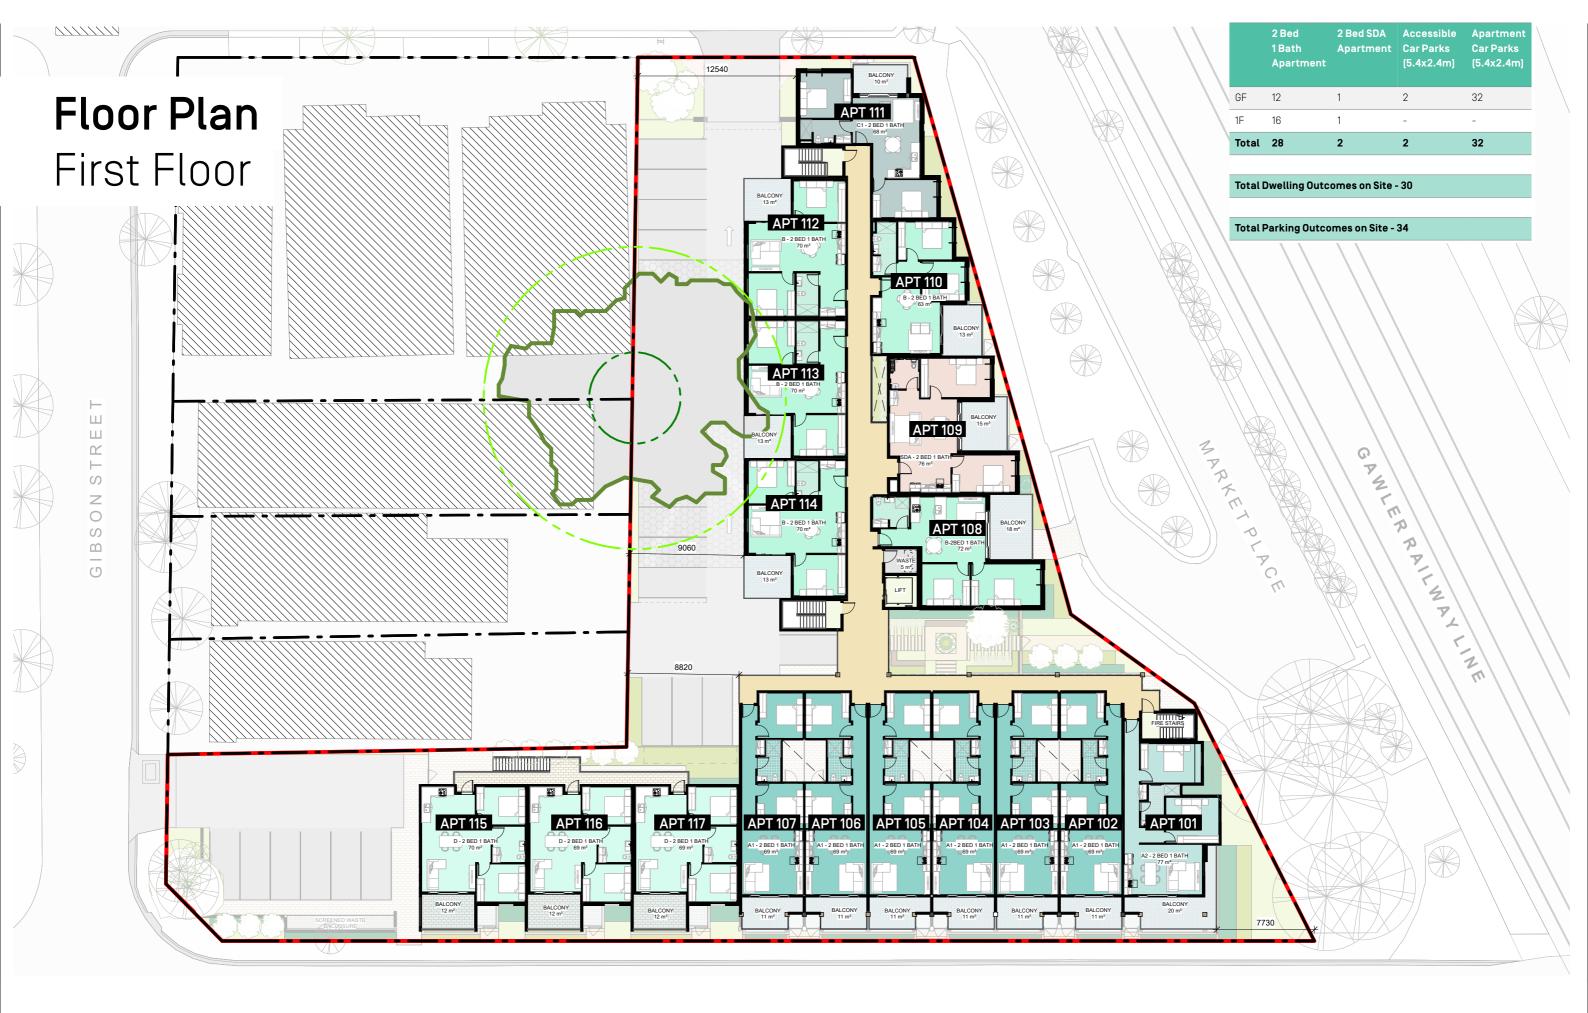











/Urban Design /Architecture Status

Drawing Title Scale

: ROOF PLAN : 1:300 : CONCEPT DESIGN



Project: Uniting on Hawker Project No: 2284 Date: 20/03/2025

Drawn: SW Checked: DC Drawing: P1003 Revision: P.06

Building Elevations




Scale: 1:200 @ A3



1. SW Elevation (Hawker Street) (Cont.)

Scale: 1:200 @ A3

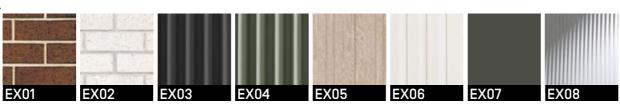

: CONCEPT DESIGN

Key Materials

EX01 - Brown Brick

EX02 - White Brick

EX03 - Corrugated Steel - Woodland Grey

EX04 - Corrugated Steel - Pale Eucalypt

EX05 - Timber Cladding

EX06 - CFC sheet - Vertical profile - White

EX07 - CFC Sheet - Woodland Grey

EX08 - Fluted Glass

Uniting SA 70 Dale Street, Port Adelaide, SA 5015 (08) 8440 2200 Collective

Drawing Title Scale Status


/Urban Design

/Architecture


: BUILDING ELEVATIONS - SHEET 1

Project: Uniting on Hawker Project No: 2284 Date: 20/03/2025 Drawn: EO Checked: DC Drawing: P2001 Revision: P.06


Building Elevations

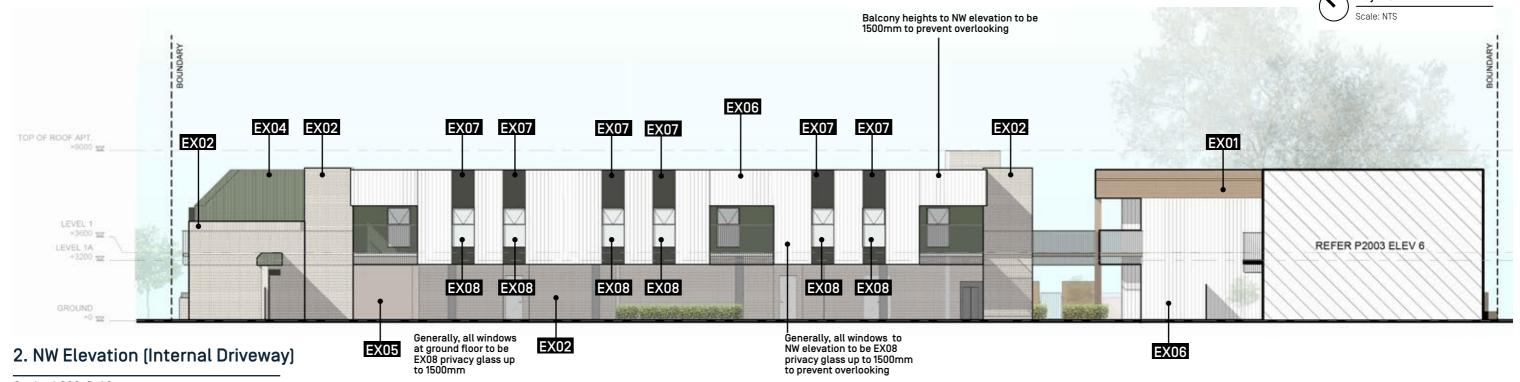

Scale: 1:200 @ A3

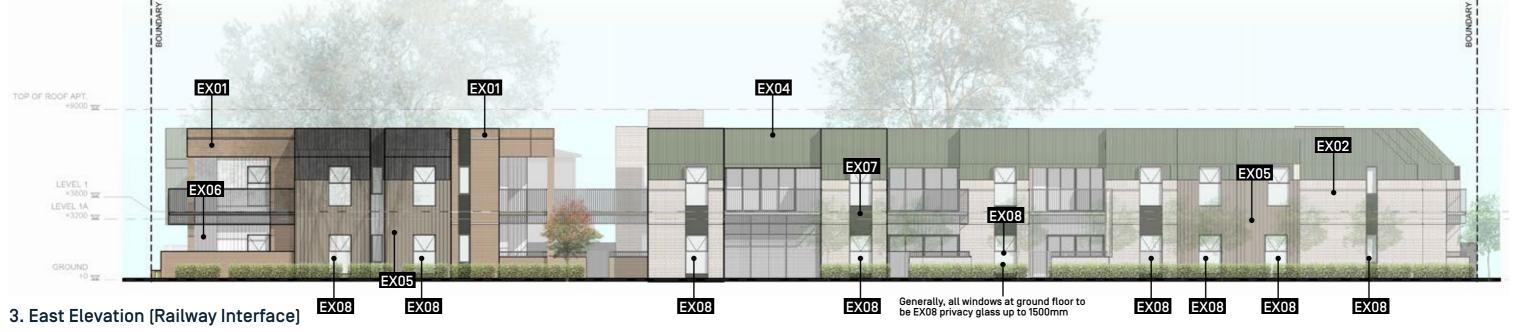

Scale: 1:200 @ A3

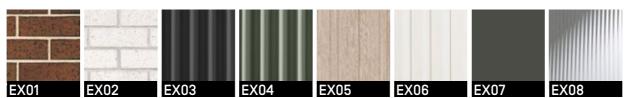

: CONCEPT DESIGN

Key Materials

EX01 - Brown Brick

EX02 - White Brick

EX03 - Corrugated Steel - Woodland Grey

EX04 - Corrugated Steel - Pale Eucalypt

EX05 - Timber Cladding

EX06 - CFC sheet - Vertical profile - White

EX07 - CFC Sheet - Woodland Grey

EX08 - Fluted Glass

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/Urban Design Scale /Architecture Status


Drawing Title

BUILDING ELEVATIONS - SHEET 2

Uniting on Hawker Project: Project No: 2284 20/03/2025


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Building Elevations

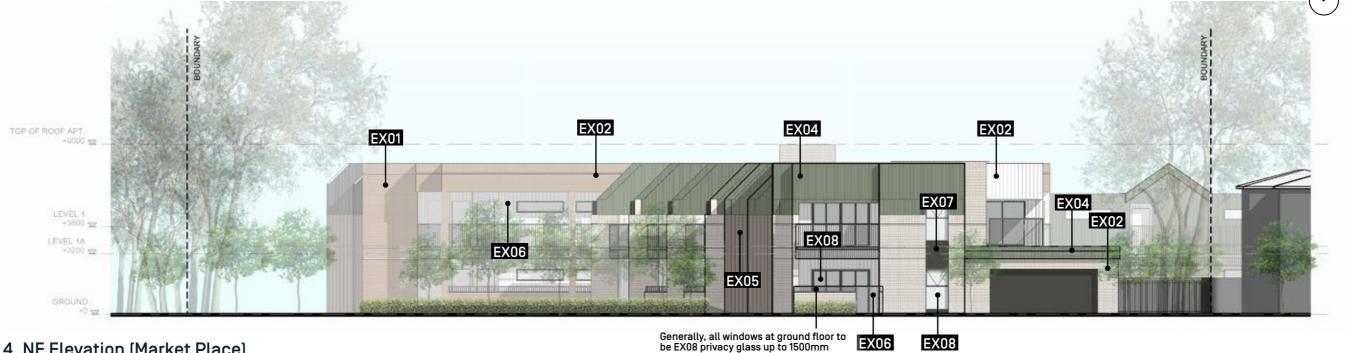


4. NE Elevation (Market Place)

Scale: 1:200 @ A3

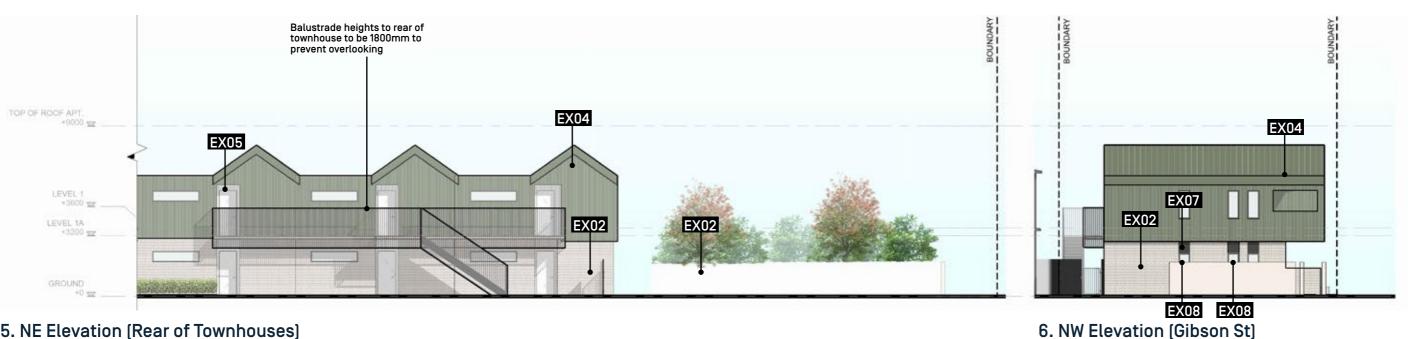

5. NE Elevation (Rear of Townhouses)

Scale: 1:200 @ A3

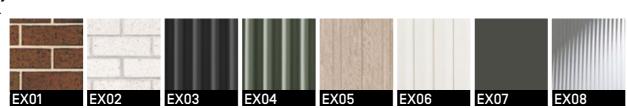

Key Materials

EX01 - Brown Brick

EX02 - White Brick

EX03 - Corrugated Steel - Woodland Grey

EX04 - Corrugated Steel - Pale Eucalypt

EX05 - Timber Cladding EX06 - CFC sheet - Vertical profile - White

EX07 - CFC Sheet - Woodland Grey

EX08 - Fluted Glass

Uniting SA Uniting Cr. 70 Dale Street, Port Adelaide, SA 5015 (08) 8440 2200

City Collective

/Urban Design /Architecture

Drawing Title Scale Status


BUILDING ELEVATIONS - SHEET 3

: CONCEPT DESIGN

Uniting on Hawker Project: Project No: 2284

Drawn: EO Checked: DC Drawing: P2003 Revision: P.06


Building Section

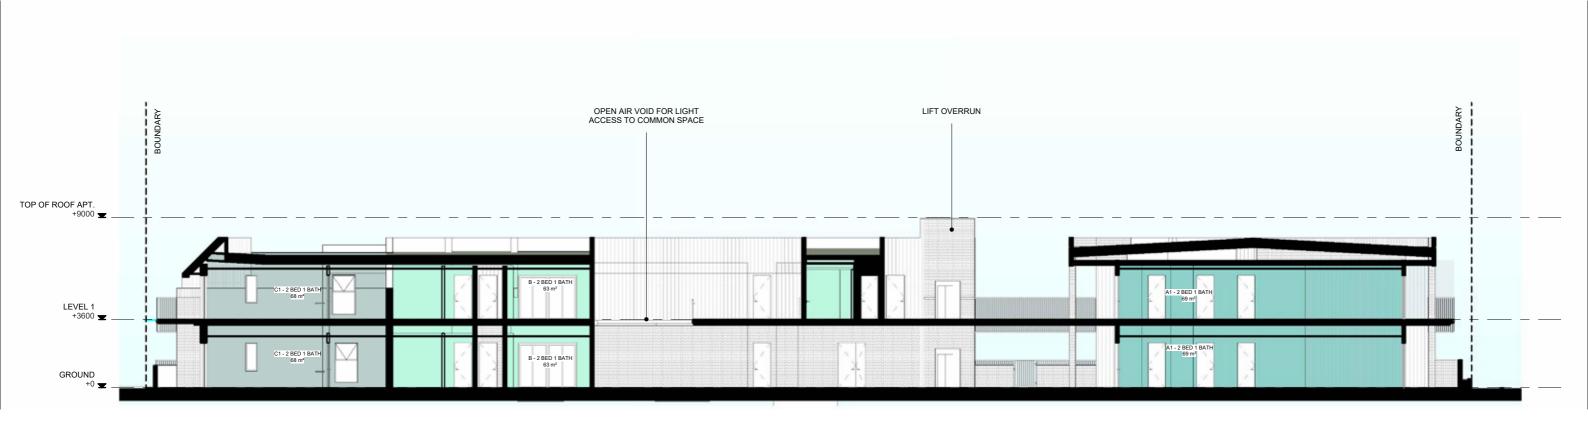

Building Section

Scale: 1:200 @ A3

Apartment Plans

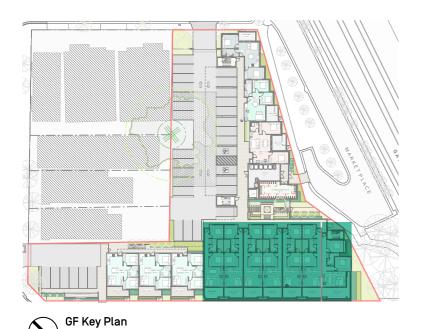


	2 Bed 1 Bath Apartment	2 Bed SDA Apartment	Accessible Car Parks [5.4x2.4m]	Apartme Car Park [5.4x2.4
GF	12	1	2	32

Total Dwelling Outcomes on Site - 30

Total 28


Total Parking Outcomes on Site - 34

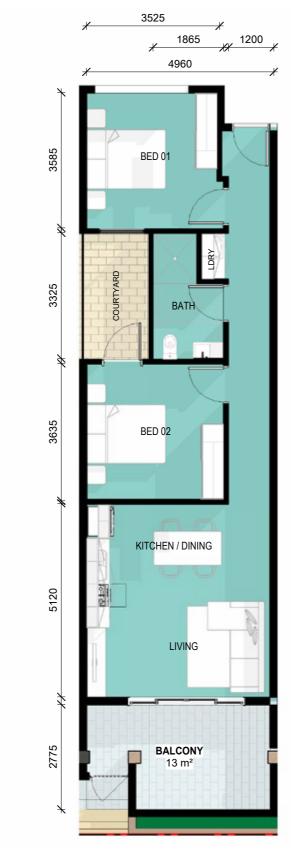

Apartment A1 Typical Plan

Scale: 1:100

Applies to APT 002-007, 102-107 Internal Area: 69m² POS: 13m² at GF, 11m² at 1F

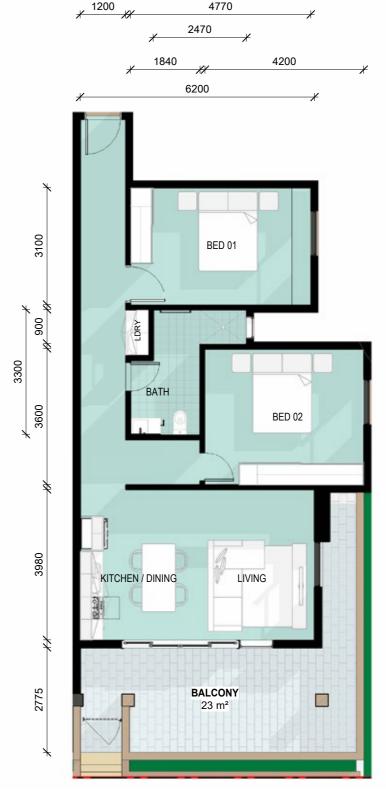

Apartment A2 Typical Plan

Scale: 1:100

Applies to APT 001, 101 Internal Area: 77m² POS: 23m² at GF, 20m² at 1F







Apartment Plans



	2 Bed 1 Bath Apartment	2 Bed SDA Apartment	Accessible Car Parks [5.4x2.4m]	Apartment Car Parks [5.4x2.4m]
GF	12	1	2	32
1F	16	1	-	-
Total	28	2	2	32

Total Dwelling Outcomes on Site - 30

Total Parking Outcomes on Site - 34



Apartment C1 Typical Plan

Scale: 1:100

Applies to APT 010, 111 Internal Area: 63m² POS: 10m²

SDA Apartment Typical Plan

Scale: 1:100

Applies to APT 008, 109 Internal Area: 76m² POS: 15m²







Apartment Plans






	2 Bed 1 Bath Apartment	2 Bed SDA Apartment	Accessible Car Parks [5.4x2.4m]	Apartment Car Parks [5.4x2.4m]
GF	12	1	2	32
1F	16	1	-	-
Total	28	2	2	32

Total Dwelling Outcomes on Site - 30

Total Parking Outcomes on Site - 34



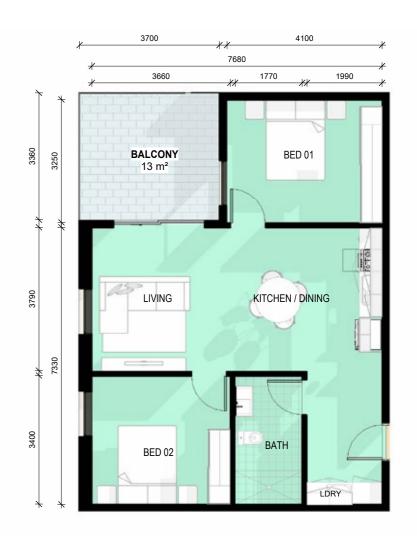

Apartment B1 Typical Plan

Scale: 1:100

Applies to APT 009, 110 Internal Area: 62m² POS: 12m² at GF, 13m² at 1F


Apartment B2 Typical Plan

Scale: 1:100

Applies to APT 112-114 Internal Area: 70m² POS: 13m²



Apartment Plans

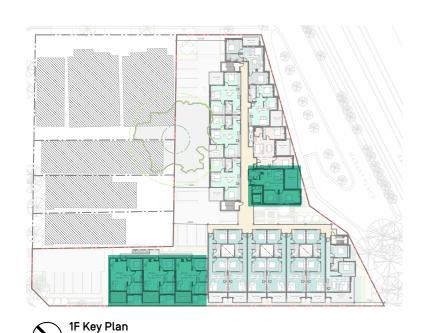



	2 Bed 1 Bath Apartment	2 Bed SDA Apartment	Accessible Car Parks [5.4x2.4m]	Apartment Car Parks [5.4x2.4m]
GF	12	1	2	32
1F	16	1	-	-
Total	28	2	2	32

Total Dwelling Outcomes on Site - 30

Total Parking Outcomes on Site - 34





5300

5900

Apartment B3 Typical Plan

Scale: 1:100

Applies to APT 108 Internal Area: 72m² POS: 18m² Apartment D Typical Plan

Scale: 1:100

Applies to APT 011-123, 015-117 Internal Area: 69m² POS: 13m² at GF, 12m² at 1F







3830

BED 02

BATH

2570










1 Landscape & Environmentally Sustainable Design



Landscape Concept Soft Landscape Design Approach

Plant Selection

- Address low light conditions with careful plant selection to ensure vibrant and healthy growth
- Enhance the courtyard experience with elegant free-standing pots and tasteful, accessible furniture for a range of ages and abilities
- Establish a peaceful and healing green space with lush foliage and small trees

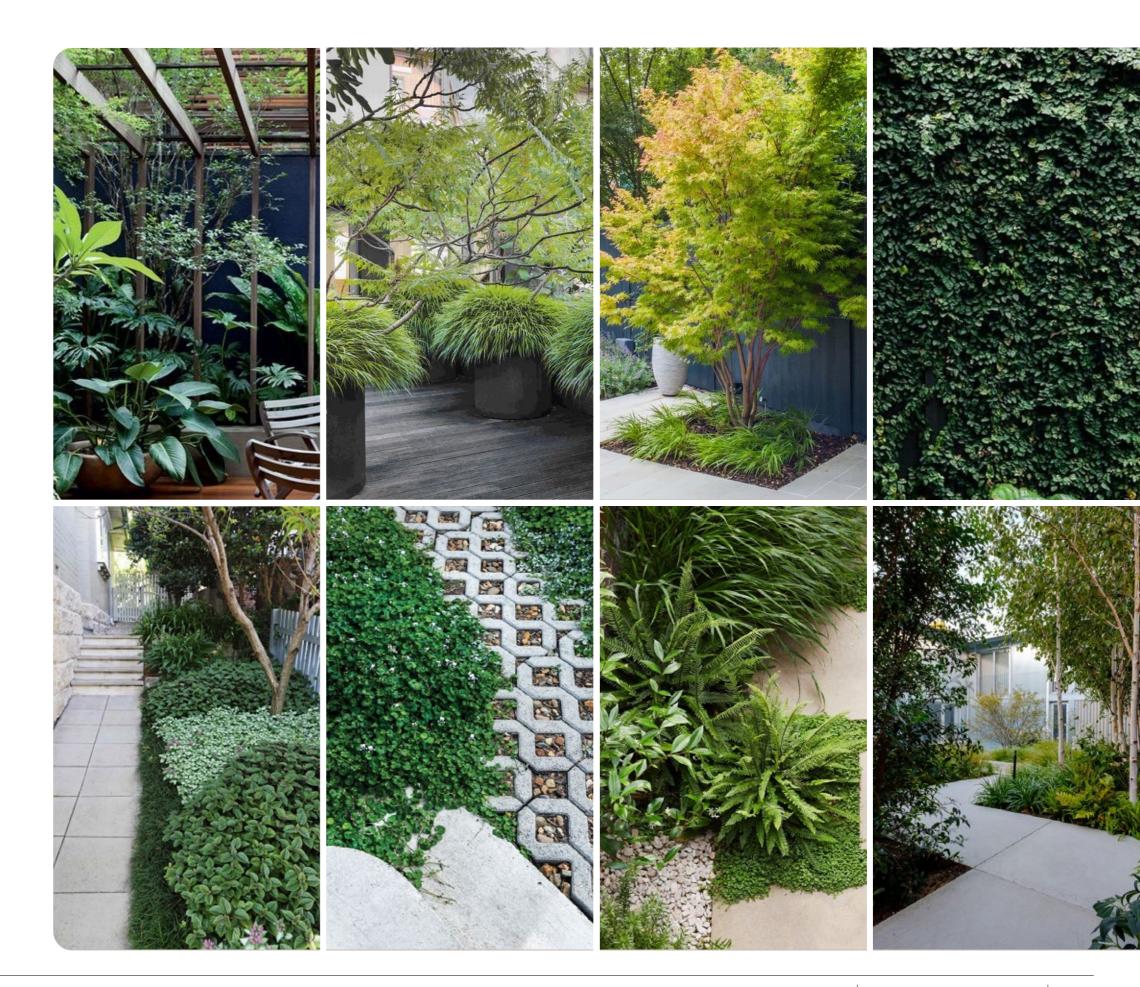


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Landscape Concept Soft Landscape Design Approach

Materiality

- Use high-quality, tactile surface materials commensurate with the scale of the spaces to define spaces for reflection and small social gathering
- Incorporate strategically placed decorative backdrops and screening for privacy and an intimate setting
- Choose inviting furniture to transform the courtyard into series of 'outdoor rooms,' extending the indoor living areas and encouraging relaxation and social interaction

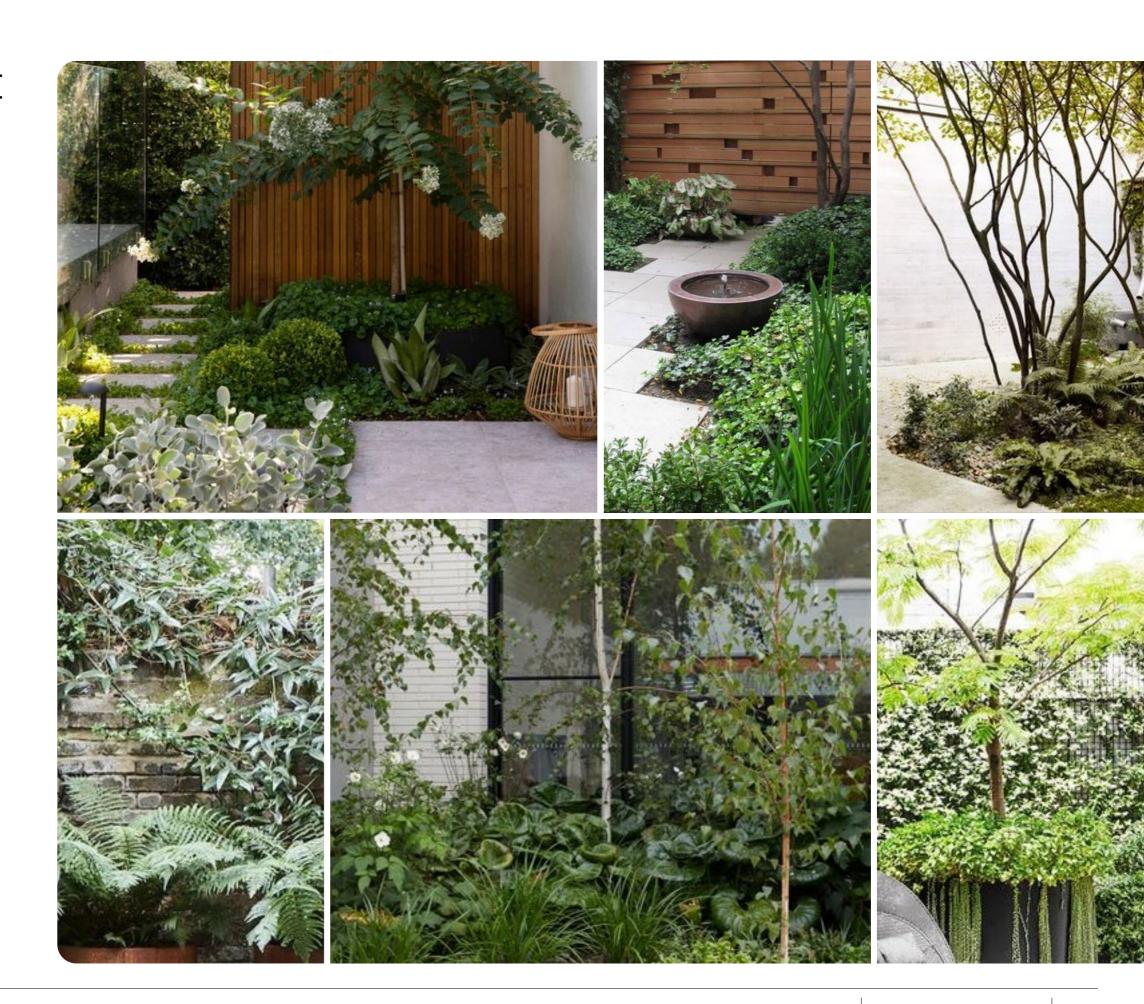


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Landscape Concept Undercrofts & Walkways

Key Features

- 1. Linear spaces, using different surface treatments to denote access paths, or moments to pause
- 2. Shade friendly ground cover and planting to control movement through spaces, and provide a soft lush space
- 3. Larger Planting to more open areas and incidental spaces
- 4. Selective use of textural backdrop pieces to define communal areas

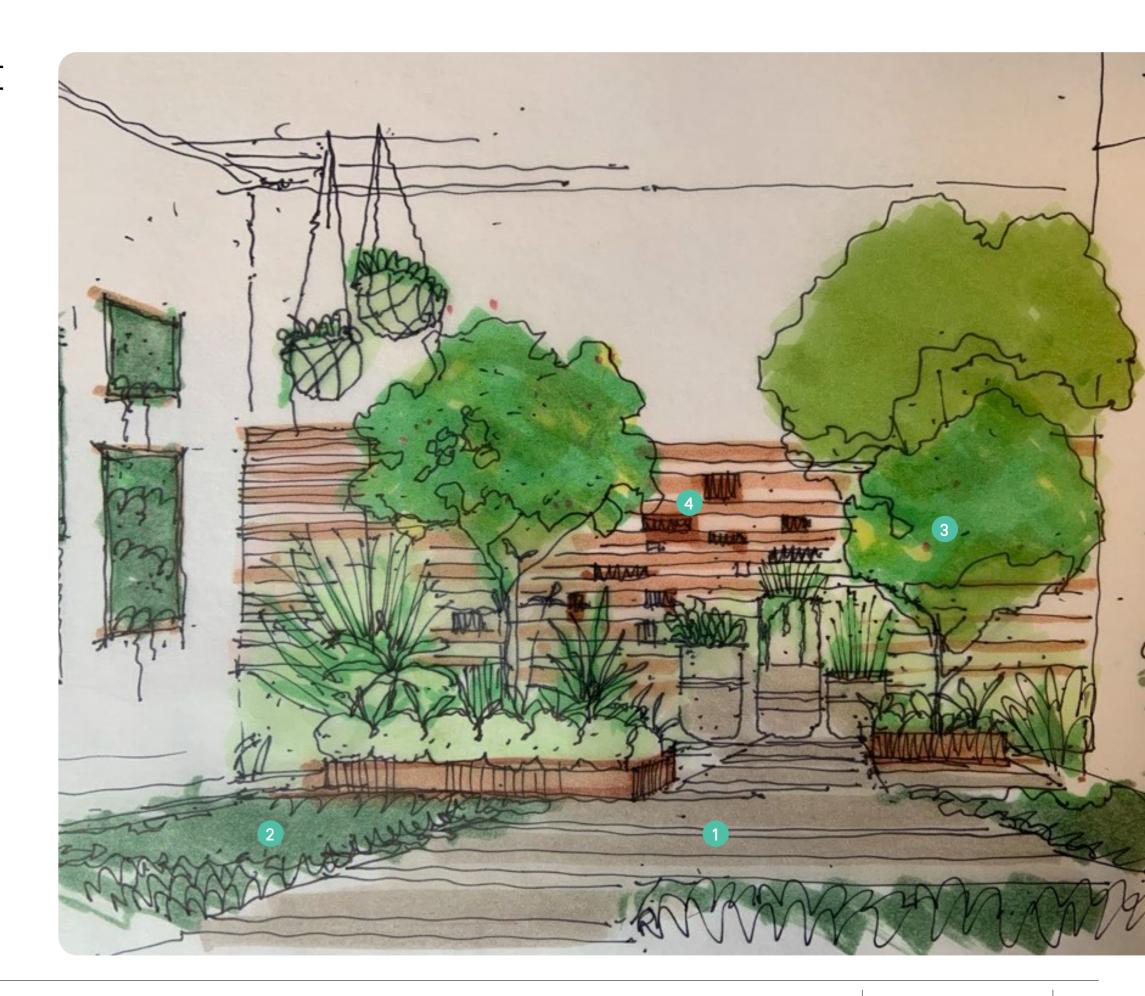

Landscape Concept

Preliminary Plan

Key Features

- 1. Address low light conditions with careful plant selection to ensure vibrant and healthy growth
- 2. Shade friendly ground cover and planting to control movement through spaces, and provide a soft lush space
- 3. Larger Planting to more open areas and incidental spaces
- 4. Opportunity for planting to soften street interface edge

Mix No. Mix Type		Size mm
MIX-01	Hawker Street Apartments	140
MIX-02	Apartment Market Place	140
MIX-03	Zen Garden	140
MIX-05	Light well & Internal Pots	140
MIX-06	Development Edge & Driveways	
MIX-07 Green Screening		140

Tree

Miv

Mix 01 - Hawker Street Town houses


Mix 02 -Apartments Market Place

Mix 03 -Zen Garden

Mix 04- Light well & Internal Pots

Mix 05- Development Edge & Driveways

Mix 06- Green Screening

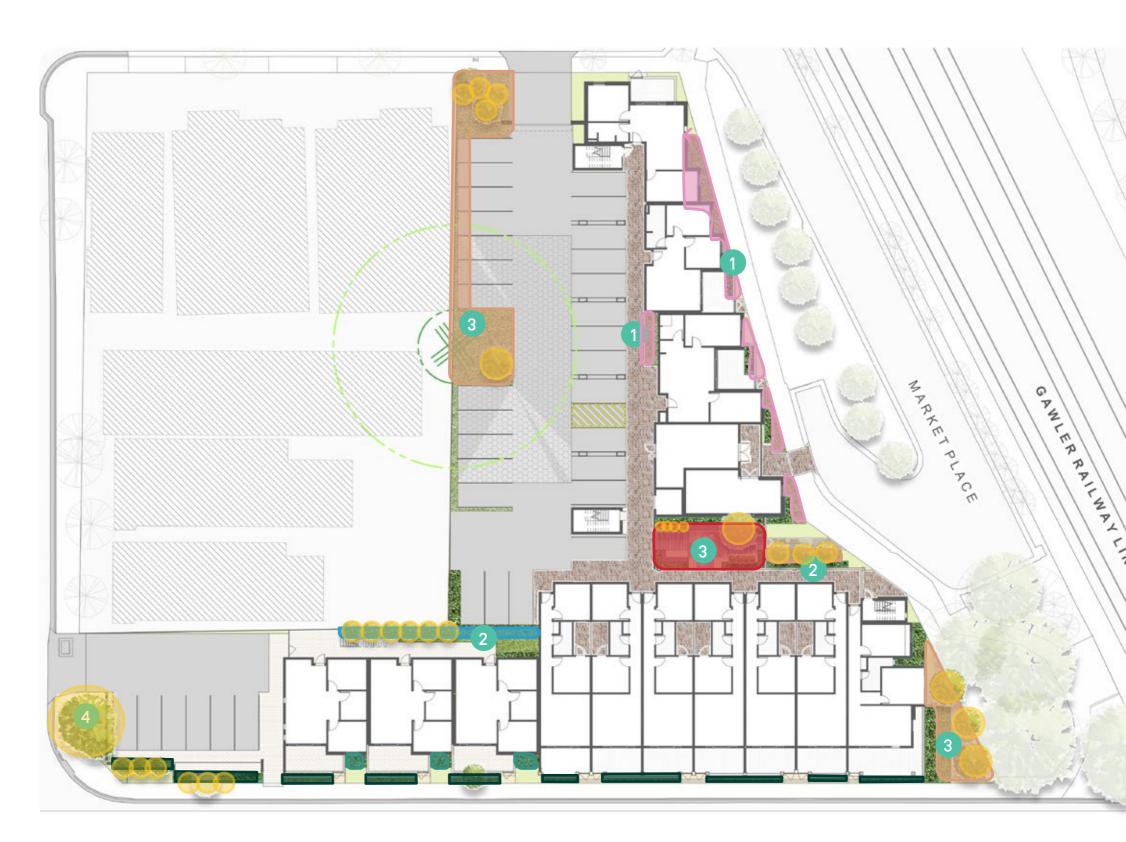



Ground Floor Plan

Scale: 1:400 @ A3

Plant Schedule

	TREE			
	Botanic Name	Common Name	Size L	Counting (m)
1	Acer palmatum	Japanese Maple	45	2
2	Tilia cordata	Linden Tree	45	3
3	Gleditsia triacanthos var. inermis 'Sunburst'	Honey Locust (Cultivar)	45	3
4	Acer buergerianum	Trident Maple	45	4
5	Pyrus calleryana	Chanticleer	45	6
6	Fraxinus pennsylvanica 'Broad Leaf'	Urbanite	45	4
7	Ulmus parvifolia	Chinese Elm	45	3

	Mix 01 Hawker Street Apartments				
	Botanic Name	Common Name	Size mm	Spacing(m)	
8	Lomandra longifolia 'Tanika'	Mat Rush	140	0.6	
9	Trachelospermum jasminoides	Star Jasmine	140	0.75	
10	Dianella caerulea 'Breeze'	Blue Flax Lily	140	0.7	
11	Hibbertia scandens	Guinea Flower	140	0.55	

	Mix 02 Apartments Market Place				
Botanic Name Common Name Size mm Spacing[m]					
12	Murraya paniculata	Mock Orange	200	0.8	
13	Raphiolepis indica 'Oriental Pearl'	Indian Hawthorn	140	0.5	
14	Rosmarinus officinalis 'Prostratus'	Prostrate Rosemary	140	0.6	



Plant Schedule

	Mix 03 Zen Garden			
	Botanic Name	Common Name	Size mm	Spacing (m)
1	Ajuga australis	Australian Bugle	140	0.3
2	Aspidistra elatior	Cast Iron Plant	140	0.6
3	Asplenium australasicum	Bird's Nest Fern	140	0.4
4	Cyrtomium falcatum	Japanese Holly Fern	140	0.7
5	Doodia aspera	Rasp Fern	140	0.3
6	Helichrysum petiolare	Licorice plant	140	0.9
7	Helichrysum splendidum	Cape Gold	140	0.7
8	Liriope muscari 'Just Right'	Just Right Liriope	140	0.7
9	Plectranthus 'Plepalila'	Mona Lavendar	140	0.6
10	Stachcys byzantina	Lamb's Ears	140	0.3
11	Trachelospermum jasminoides	Star Jasmine	140	0.75
12	Viola hederacea	Native Violet	140	0.7

	Mix 04 Light Well & Internal Pots					
	Botanic Name	Common Name	Size mm	Spacing (m)		
13	Asplenium australasicum	Bird's Nest Fern	140	0.6		
14	Clivea miniata	Bush Lily	140	0.4		
15	Philodendron 'Xanadu'	Philodendron 'Xanadu'	140	0.5		
16	Plectranthus 'Plepalila'	Mona Lavendar	140	1.1		




Plant Schedule


Mix 05 Development Edge & Driveway					
	Botanic Name	Common Name	Size mm	Spacing (m)	
1	Dianella revoluta 'Revelation'	Bird's Nest Fern	140	0.5	
2	Ficinia nodosa	Bush Lily	140	0.5	
3	Hardenbergia 'Bushy Blue'	Philodendron 'Xanadu'	140	0.6	
4	Leucophyta brownii	Mona Lavendar	140	0.4	
5	Lomandra longifolia 'Tanika'	Mat Rush	140	0.5	
6	Myoporum parvifolium 'Fine Leaf Form'	Creeping Boobialla	140	0.55	
7	Poa labillardieri 'Eskdale'	Tussock Grass	140	0.6	
8	Westringia 'Wynyabbie Gem'	Coastal Rosemary	140	0.4	
9	Westringia Fruticosa 'Smokey'	Coastal Rosemary	140	0.55	

Mix 06 Green Screen				
	Botanic Name	Common Name	Size mm	Spacing [m]
10	Murray paniculata	Mock Orange	140	0.5



Shadow Diagrams

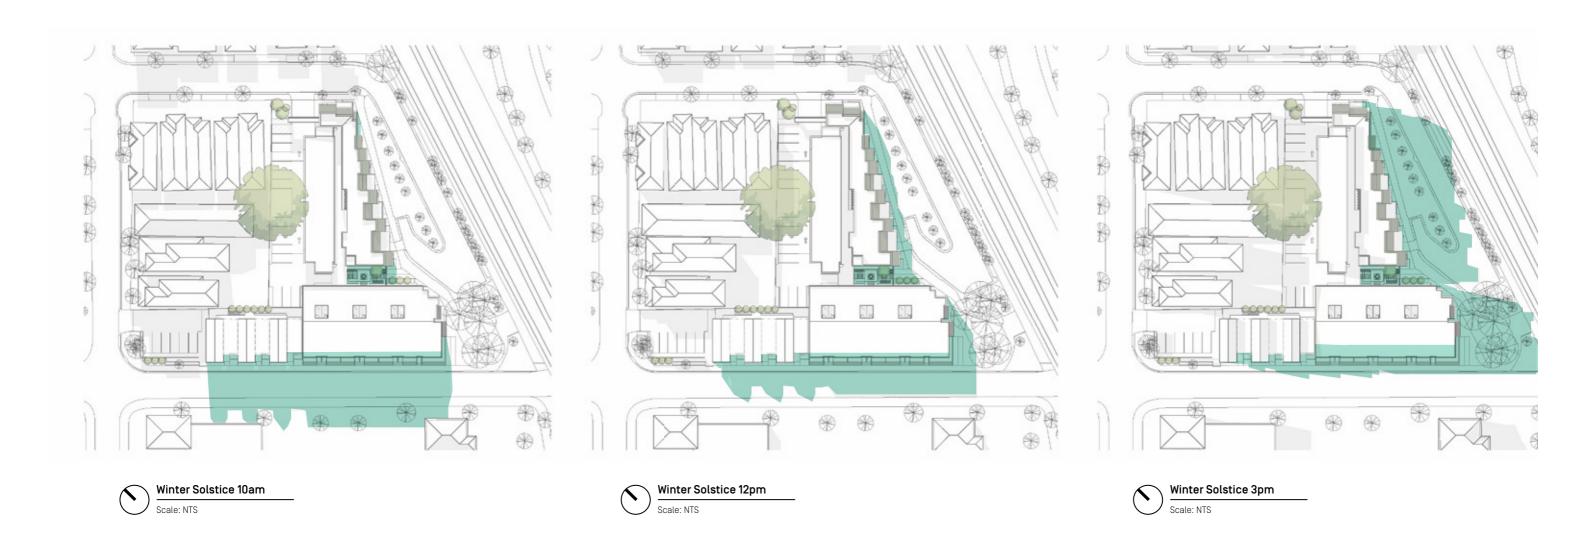

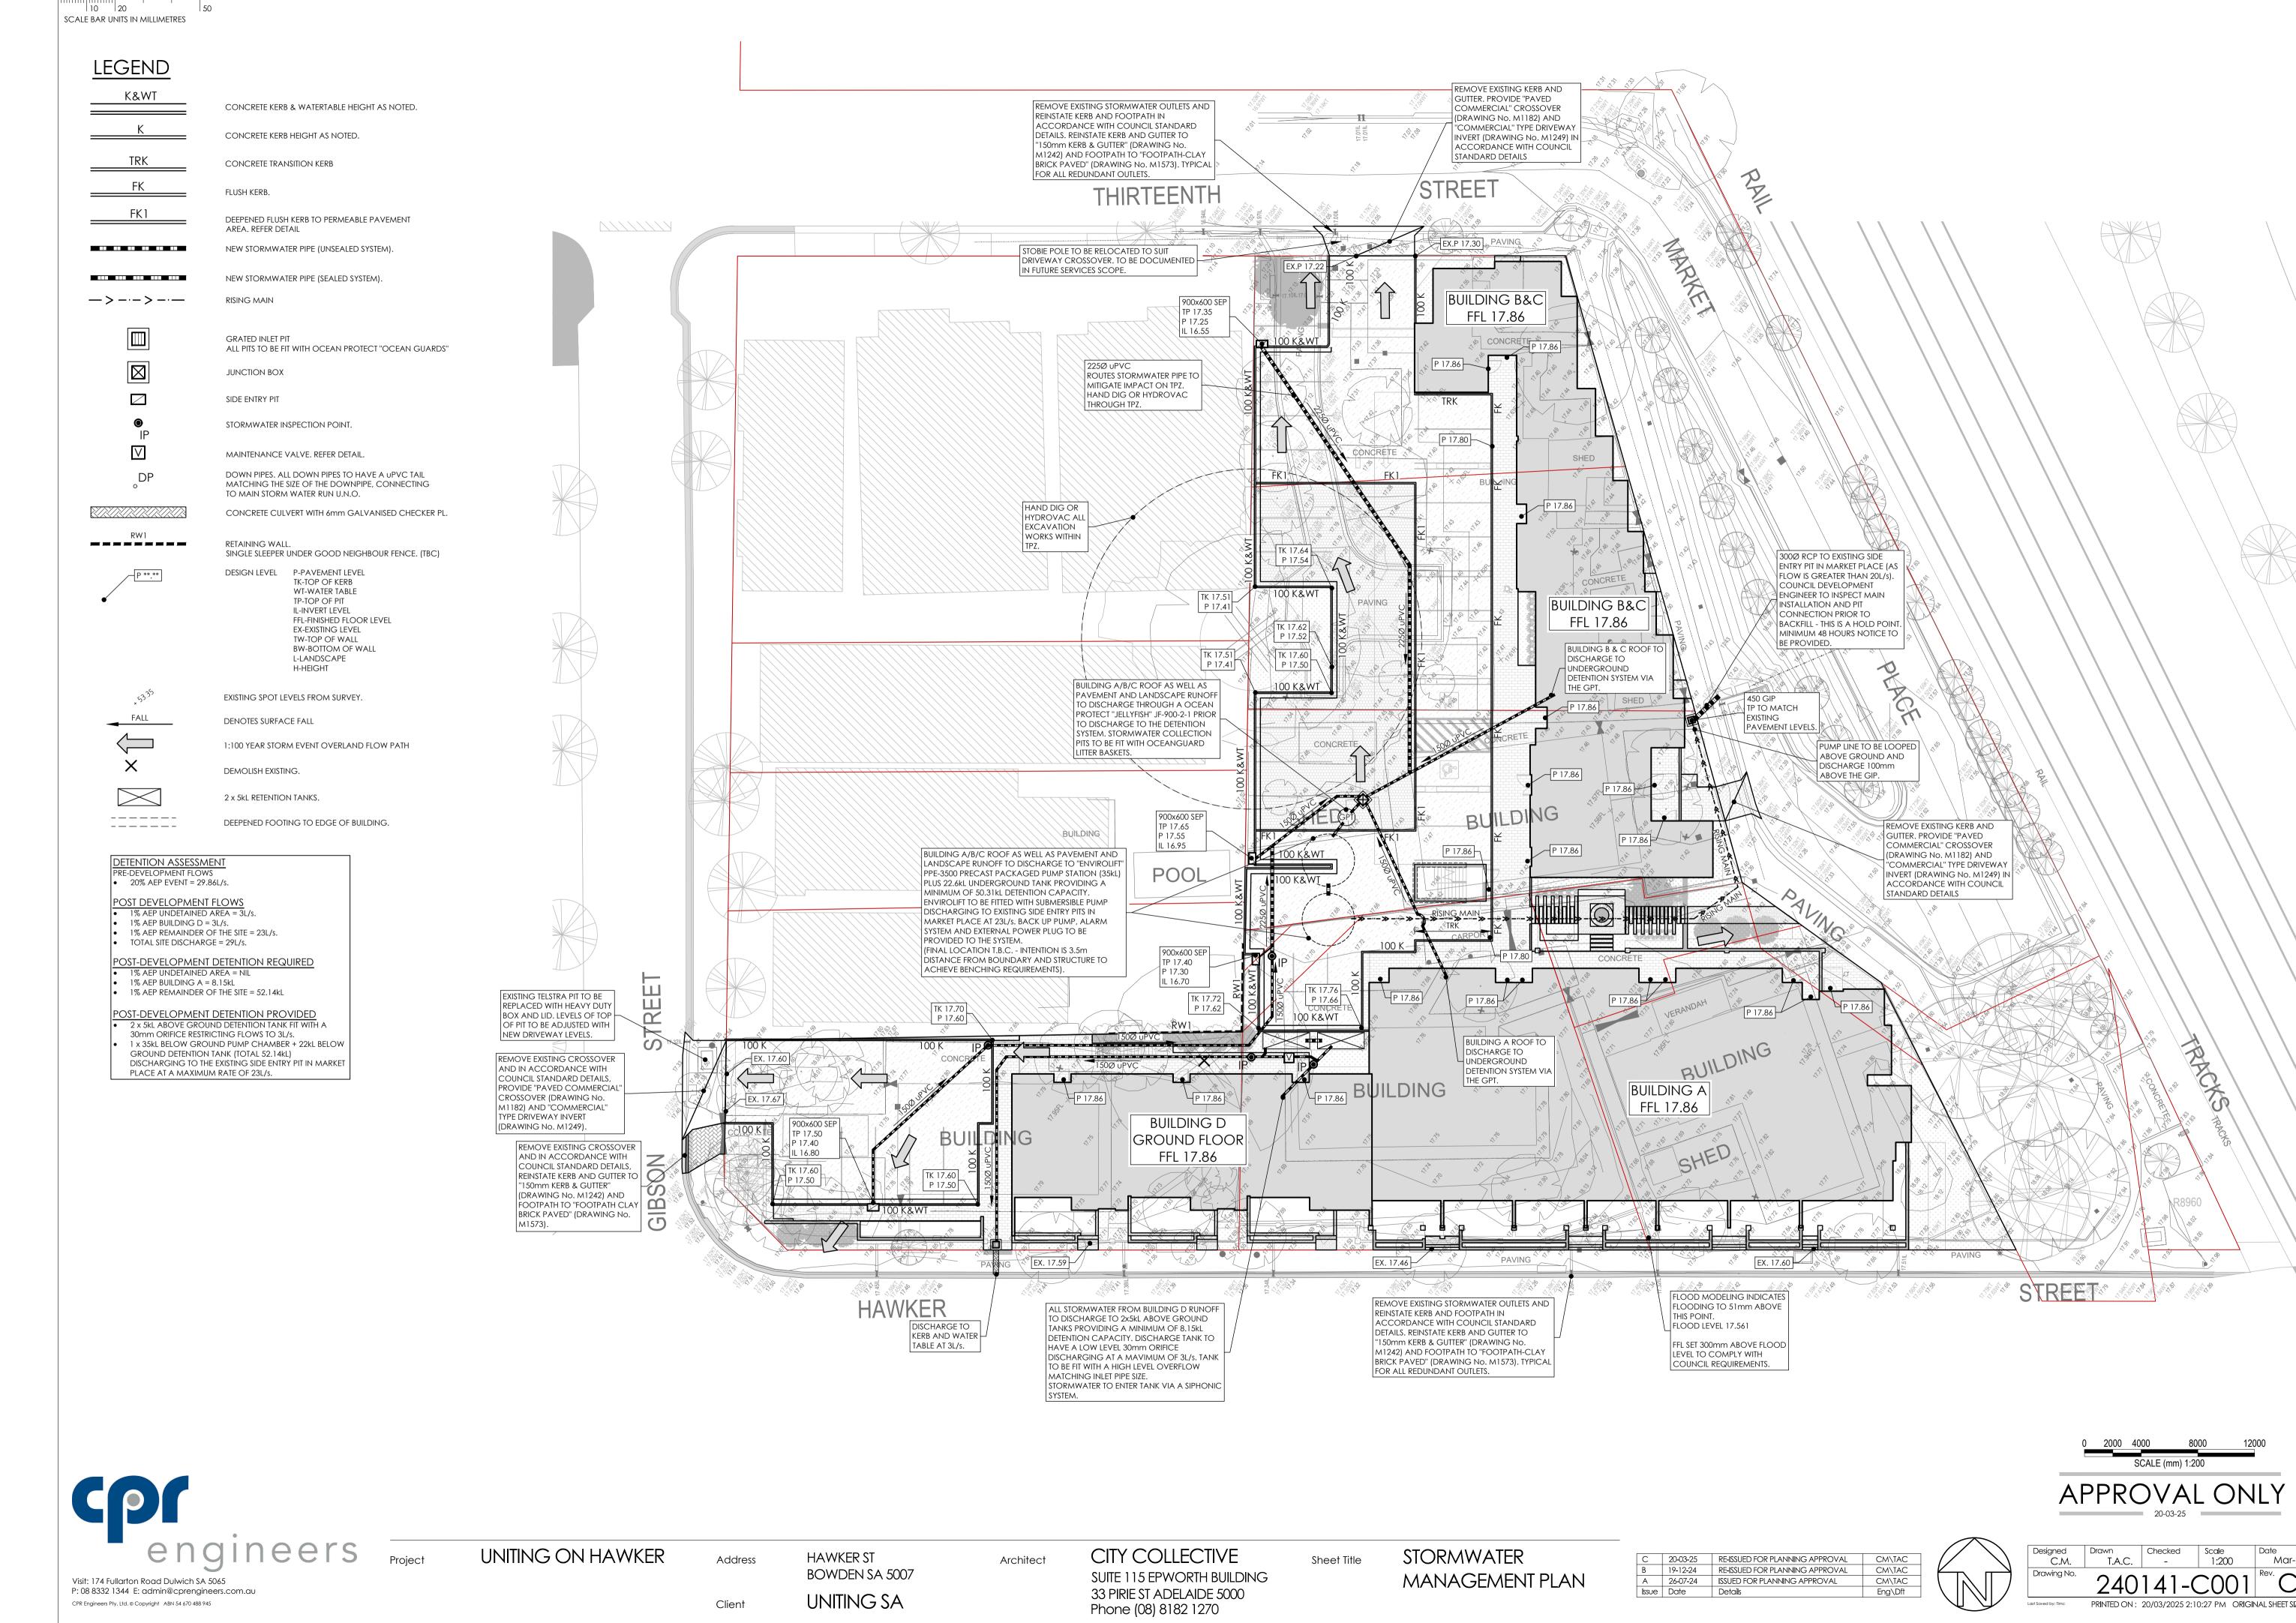

UNITING ON HAWKER

Address BOWDEN SA 5007

Client

UNITING SA

Architect

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STORMWATER MANAGEMENT PLAN

RE-ISSUED FOR PLANNING APPROVAL RE-ISSUED FOR PLANNING APPROVAL CM\TAC 19-12-24 A 26-07-24 Issue Date ISSUED FOR PLANNING APPROVAL

Designed C.M.

PRINTED ON: 20/03/2025 2:10:27 PM ORIGINAL SHEET SIZE A1